



DEPARTMENT OF REGULATORY AND ECONOMIC RESOURCES (RER)
BOARD AND CODE ADMINISTRATION DIVISION

NOTICE OF ACCEPTANCE (NOA)

MIAMI-DADE COUNTY, FLORIDA
PRODUCT CONTROL SECTION
11805 SW 26th Street, Room 208
Miami, Florida 33175-2474
T (786) 315-2590 F (786) 315-2599

www.miamidade.gov/economy

Kawneer Company, Inc.
555 Guthridge Court
Norcross, GA 30092

SCOPE:

This NOA is being issued under the applicable rules and regulations governing the use of construction materials. The documentation submitted has been reviewed and accepted by Miami-Dade County RER – Product Control Section to be used in Miami-Dade County and other areas where allowed by the Authority Having Jurisdiction (AHJ).

This NOA shall not be valid after the expiration date stated below. The Miami-Dade County Product Control Section (In Miami-Dade County) and/ or the AHJ (in areas other than Miami-Dade County) reserve the right to have this product or material tested for quality assurance purposes. If this product or material fails to perform in the accepted manner, the manufacturer will incur the expense of such testing and the AHJ may immediately revoke, modify, or suspend the use of such product or material within their jurisdiction. RER reserves the right to revoke this acceptance, if it is determined by Miami-Dade County Product Control Section that this product or material fails to meet the requirements of the applicable building code.

This product is approved as described herein, and has been designed to comply with the Florida Building Code, including the High Velocity Hurricane Zone.

DESCRIPTION: Series "8400TL" Thermal Broken Aluminum Horizontal Slider Window – S.M.I.

APPROVAL DOCUMENT: Drawing No. 1757, series titled "8400TL Sliding Glass Window (Small Missile Impact)", sheets 01 through 07 of 07, dated 06/13/11 with the latest revision, dated 09/21/11, prepared by W. W. Schaefer Engineering & Consulting, P. A., signed and sealed by Warren W. Schaefer, P. E., bearing the Miami-Dade County Product Control Revision stamp with the Notice of Acceptance number and Expiration date by the Miami-Dade County Product Control Section.

MISSILE IMPACT RATING: Small Missile Impact Resistant.

LIMITATIONS: Miami-Dade County Product Control Approved External Shutters Or Protective Devices Shall Be Required Within The Lowest 30 Feet Above Grade Of The Exterior Building.

LABELING: Each unit shall bear a permanent label with the manufacturer's name or logo, city, state, series and following statement: "Miami-Dade County Product Control Approved" unless otherwise noted herein.

RENEWAL of this NOA shall be considered after a renewal application has been filed and there has been no change in the applicable building code negatively affecting the performance of this product.

TERMINATION of this NOA will occur after the expiration date or if there has been a revision or change in the materials, use, and/ or manufacture of the product or process. Misuse of this NOA as an endorsement of any product, for sales, advertising or any other purposes shall automatically terminate this NOA. Failure to comply with any section of this NOA shall be cause for termination and removal of NOA.

ADVERTISEMENT: The NOA number preceded by the words Miami-Dade County, Florida, and followed by the expiration date may be displayed in advertising literature. If any portion of the NOA is displayed, then it shall be done in its entirety.

INSPECTION: A copy of this entire NOA shall be provided to the user by the manufacturer or its distributors and shall be available for inspection at the job site at the request of the Building Official.

This NOA revises NOA No. 11-0705.12 and consists of this page 1, evidence pages E-1 and E-2, as well as approval document mentioned above.

The submitted documentation was reviewed by Jaime D. Gascon, P. E.



J. Gascon
7/22/14

NOA No. 14-0430.06
Expiration Date: October 06, 2016
Approval Date: July 31, 2014
Page 1

NOTICE OF ACCEPTANCE: EVIDENCE SUBMITTED

A. DRAWINGS

1. Manufacturer's die drawings and sections.
(Submitted under previous NOA No. 11-0705.12)
2. Drawing No. 1757, series titled "8400TL Sliding Glass Window (Small Missile Impact)", sheets 01 through 07 of 07, dated 06/13/11 with the latest revision, dated 09/21/11, prepared by W. W. Schaefer Engineering & Consulting, P. A., signed and sealed by Warren W. Schaefer, P. E.
(Submitted under previous NOA No. 11-0705.12)

B. TESTS

1. Test reports on:
 - 1) Air Infiltration Test, per FBC, TAS 202-94
 - 2) Uniform Static Air Pressure Test, Loading per FBC TAS 202-94
 - 3) Water Resistance Test, per FBC, TAS 202-94
 - 4) Small Missile Impact Test per FBC, TAS 201-94
 - 5) Cyclic Wind Pressure Loading per FBC, TAS 203-94
 - 6) Forced Entry Test, Type "A" horizontal sliding window, Grade 10, per FBC 2411 3.2.1, TAS 202-94 and per ASTM F 588-04along with marked-up drawings and installation diagram of horizontal sliding window, prepared by Hurricane Test Laboratory, LLC, Test Report No. **HTL G049-0801-10**, dated 06/15/11, signed and sealed by Vinu J. Abraham, P. E.
(Submitted under previous NOA No. 11-0705.12)

C. CALCULATIONS


1. Anchor verification calculations and structural analysis, complying with FBC, prepared by W. W. Schaefer Engineering & Consulting, P. A., dated 06/21/11, signed, sealed and dated 09/21/11 by Warren W. Schaefer, P. E.
(Submitted under previous NOA No. 11-0705.12)
2. Glazing complies with ASTM E1300-04/ 09

D. QUALITY ASSURANCE

1. Miami-Dade Department of Regulatory and Economic Resources (RER).

E. MATERIAL CERTIFICATIONS

1. Notice of Acceptance No. 13-0129.27 issued to E.I. DuPont DeNemours & Co., Inc. for their "DuPont Butacite® PVB Interlayer" dated 04/11/13, expiring on 12/11/16.
2. Notice of Acceptance No. 12-1231.09 issued to Eastman Chemical Company (MA) for their "Saflex HP Clear or Color Glass Interlayers" dated 03/28/13, expiring on 04/14/18.

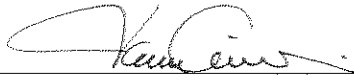
Jaime D. Gascon, P. E.
Product Control Section Supervisor
NOA No. 14-0430.06
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E. MATERIAL CERTIFICATIONS (CONTINUED)

3. TREMCO Part No. **TR-14271E** EPDM exterior glazing gasket complying with ASTM C864 Option II exceptions, ASTM D412 1600 PSI, D395B 22 HRS 158°F.
(Submitted under previous NOA No. 11-0705.12)

F. STATEMENTS


1. Statement letter of conformance to and compliance with the **FBC 5th Edition (2014)**, prepared by W. W. Schaefer Engineering & Consulting, P. A., dated 04/14/14, signed and sealed by Warren W. Schaefer, P. E.
2. Statement letter of conformance to and compliance with the **FBC-2010**, dated 09/21/11, signed and sealed by Warren W. Schaefer, P. E.
(Submitted under previous NOA No. 11-0705.12)
3. Statement letter of independence, no financial interest, conformance to and compliance with the **FBC-2007**, dated 06/29/11, signed and sealed by Warren W. Schaefer, P. E.
(Submitted under previous NOA No. 11-0705.12)
4. Laboratory compliance letter for Test Report No. **HTL G049-0801-10**, issued by Hurricane Test Laboratory, LLC, dated 06/15/11, signed and sealed by Vinu J. Abraham, P. E.
(Submitted under previous NOA No. 11-0705.12)

G. OTHERS


1. Notice of Acceptance No. **11-0705.12**, issued to Kawneer Company, Inc. for their Series "**8400TL Aluminum Horizontal Slider Window - S.M.I.**", approved on 10/06/11 and expiring on 10/06/16.



Jaime D. Gascon, P. E.
Product Control Section Supervisor
NOA No. 14-0430.06
Expiration Date: October 06, 2016
Approval Date: July 31, 2014

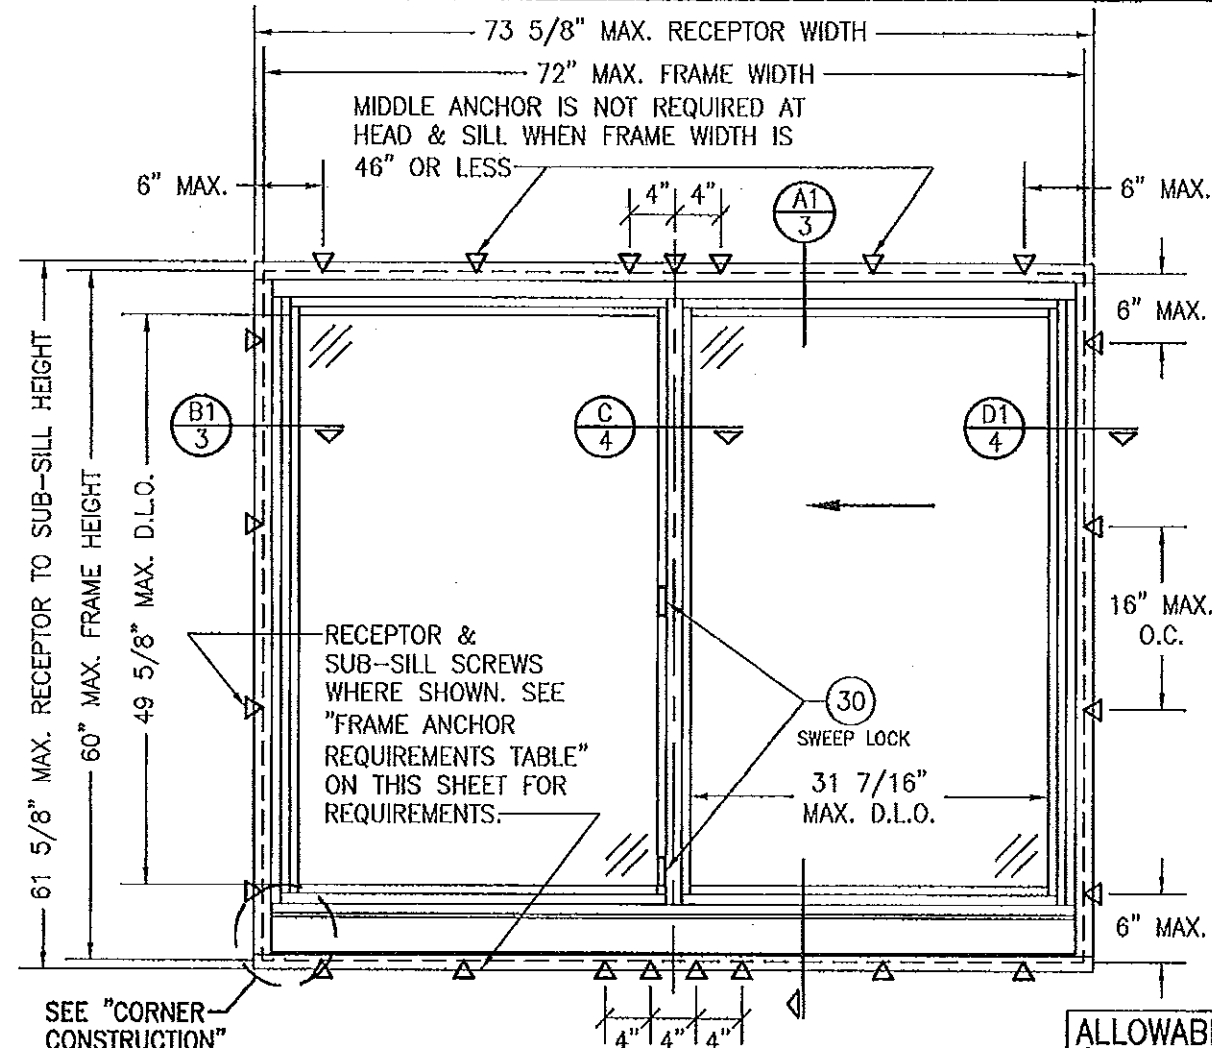

**EXTERIOR ELEVATION:
INDIVIDUAL WINDOW
(RECEPTOR MOUNT CONDITION)**
SCALE: 3/4" = 1'-0"
(OX SHOWN, XO ALSO APPLIES)

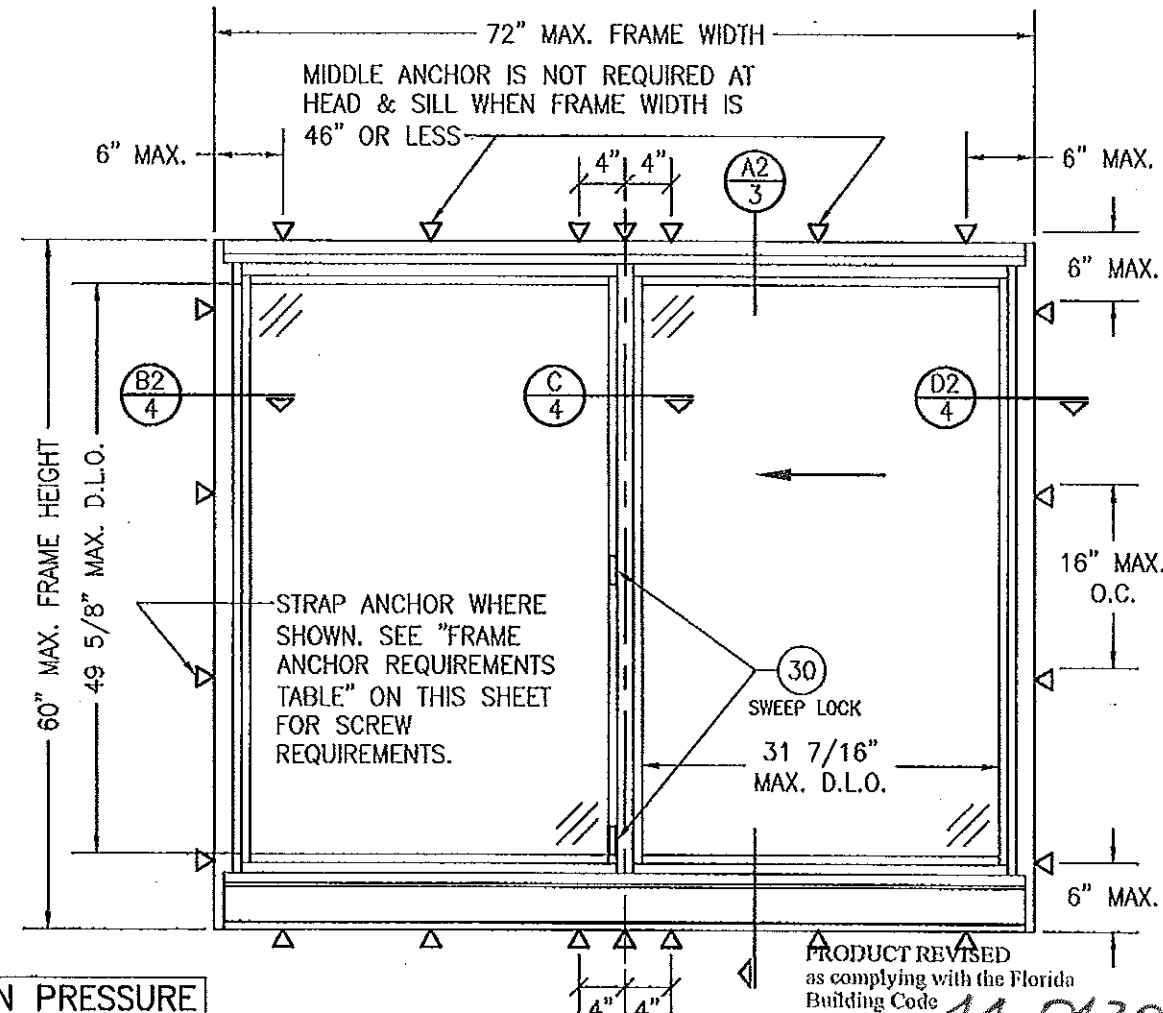

**EXTERIOR ELEVATION:
INDIVIDUAL WINDOW
(STRAP ANCHOR MOUNT CONDITION)**
SCALE: 3/4" = 1'-0"
(OX SHOWN, XO ALSO APPLIES)

**ALLOWABLE DESIGN PRESSURE
(SINGLE & MULLED WINDOWS)**
+/-90 PSF

PRODUCT REVISED
as complying with the Florida
Building Code
Acceptance No. 14-0430.06
Expiration Date 10/06/2016
By [Signature] Product Control

CORNER CONSTRUCTION:

FRAME HEAD: VERTICAL MEMBERS ARE COPE, BUTTED AND JOINED TO THE HEAD MEMBER WITH 2 NO. 8 X 1 1/4" PH TORX FASTENERS AND SEALED WITH TREMCO-TREMSIL 600 SEALANT.
FRAME SILL: VERTICAL MEMBERS ARE COPE, BUTTED AND JOINED TO THE SILL MEMBER WITH 4 NO. 8 X 1 1/4" PH TORX FASTENERS AND SEALED WITH TREMCO-TREMSIL 600 SEALANT.
SASH: VERTICAL MEMBERS ARE NOTCHED WHILE THE HORIZONTAL MEMBERS ARE SQUARE CUT, JOINED TO THE VERTICAL MEMBERS WITH A SASH CAM & 2 NO. 8 X 1 1/4" PH TORX FASTENERS AND SEALED WITH TREMCO-TREMSIL 600 SEALANT.

GENERAL NOTES:


1. THESE WINDOW SYSTEMS HAVE BEEN TESTED, ANALYZED & APPROVED FOR DESIGN PRESSURES NOT TO EXCEED THOSE SHOWN IN THE "ALLOWABLE DESIGN PRESSURE TABLE(S)".
2. OPENINGS, BUCKING & BUCKING FASTENERS MUST BE PROPERLY DESIGNED & INSTALLED TO TRANSFER WIND LOADS TO THE STRUCTURE.
3. ALL HARDWARE & FASTENERS SHALL BE IN ACCORDANCE WITH THESE DRAWINGS & SHALL NOT VARY UNLESS SPECIFICALLY MENTIONED ON THE DRAWINGS. SPECIFIED ANCHOR EMBED TO BASE MATERIAL SHALL BE BEYOND WALL FINISH OR STUCCO.
4. THE DETAILS & SPECIFICATIONS SHOWN HEREIN REPRESENT THE PRODUCTS TESTED & PROPOSED FOR WATER, AIR, IMPACT, CYCLIC & UNIFORM STATIC AIR PRESSURE TESTING IN CONFORMANCE WITH THE FLORIDA BUILDING CODE PROTOCOLS TAS-201, 202 & 203 FOR SMALL MISSILE IMPACT WINDOWS.
5. THESE WINDOW SYSTEMS HAVE BEEN DESIGNED IN ACCORDANCE WITH AND MEET THE REQUIREMENTS OF THE FLORIDA BUILDING CODE (FBC) INCLUDING HIGH VELOCITY HURRICANE ZONES (HVHZ).
6. WHEN GLAZED FOR SMALL MISSILE IMPACT, THESE WINDOWS MAY NOT BE INSTALLED AT ELEVATIONS BELOW 30 FT. ABOVE GRADE WITHOUT AN APPROVED SHUTTER.
7. ALL ANCHORS SECURING WINDOW FRAME TO PRESSURE TREATED BUCKS OR WOOD FRAMING SHALL BE CAPABLE OF RESISTING CORROSION CAUSED BY THE PRESSURE TREATING CHEMICALS IN THE WOOD.
8. DETERMINE THE POSITIVE & NEGATIVE DESIGN LOADS TO USE WHEN REFERENCING THESE DOCUMENTS IN ACCORDANCE WITH THE GOVERNING CODE AND GOVERNING WIND VELOCITY. FOR WIND LOAD CALCULATIONS IN ACCORDANCE WITH THE FLORIDA BUILDING CODE, A DIRECTIONALITY FACTOR OF $K_d = 0.85$ MAY BE APPLIED PER THE ASCE-7 STANDARD.
9. NO INCREASE IN ALLOWABLE STRESS HAS BEEN USED IN THE CERTIFICATION OF THIS PRODUCT. WIND LOAD DURATION FACTOR $C_d = 1.8$ WAS USED FOR WOOD SCREW ANALYSIS ONLY.
10. MATERIALS, INCLUDING BUT NOT LIMITED TO STEEL SCREWS, THAT COME INTO CONTACT WITH OTHER DISSIMILAR MATERIALS SHALL MEET THE REQUIREMENTS OF FLORIDA BUILDING CODE CHAPTER 20.

ANCHOR REQUIREMENTS TABLE


OPENING TYPE (SUBSTRATE)	FRAME TO OPENING FASTENER TYPE	MINIMUM EMBED	MINIMUM EDGE DIST.
RECEPTOR, SUB-SILL, STRAP ANCHOR & MULLION CLIP SCREWS			
MIN. 2X4 WOOD FRAME OR BUCK (MIN. GR. 3 & G=0.55)	NO. 14 SMS OR WOOD SCREW	1 1/4"	3/4"
MIN. 18 GA. 33 KSI METAL STUD	1/4" GR. 5 SELF TAP/DRILL SCREW	FULL	1/2"
MIN. 1/8" THK A36 STEEL	1/4" GR. 5 SELF TAP/DRILL SCREW	FULL	1/2"
MIN. 0.100" THK 6063-T6 ALUM.	1/4" GR. 5 SELF TAP/DRILL SCREW	FULL	1/2"
(2) MIN. C-90 CMU	(1) 1/4" CONCRETE SCREW	1 1/4"	2"
MIN. 3000 PSI CONCRETE	(1) 1/4" CONCRETE SCREW	1 1/2"	2"

(1) CONCRETE SCREWS SHALL BE ELCO ULTRACONS, ELCO CRETE-FLEX, ITW RAMSET/RED HEAD TAPCONS OR HILTI KWIK-CON II (HARDENED STEEL OR S.S.).

(2) CMU IS NOT APPLICABLE AT HEAD & SILL.

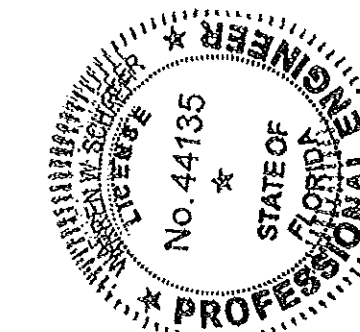


DRAWN BY: W.W.S.		CHECKED BY: W.W.S.	
PLOT: 1-18		DATE: 08/13/11	
NO.	REVISION DESCRIPTION	DATE	BY
DRAWING TITLE 8400TL SLIDING GLASS WINDOW (SMALL MISSILE IMPACT)			
MANUFACTURER KAWNEER COMPANY, INC. 555 GUTHRIE COURT NORCROSS, GA 30092 770-449-5555		CONSULTANTS W. W. SCHAEFER ENGINEERING & CONSULTING, P.A. (CA 6809) 7480 150TH COURT NORTH PALM BEACH GARDENS, FL 33418 PHONE: 561-744-3424	
CERTIFICATION SEP 21 2011 W. W. SCHAEFER, P.E. P.E. NO. 44135		DRAWING NO. 1757 SHEET NO. 1 OF 7	

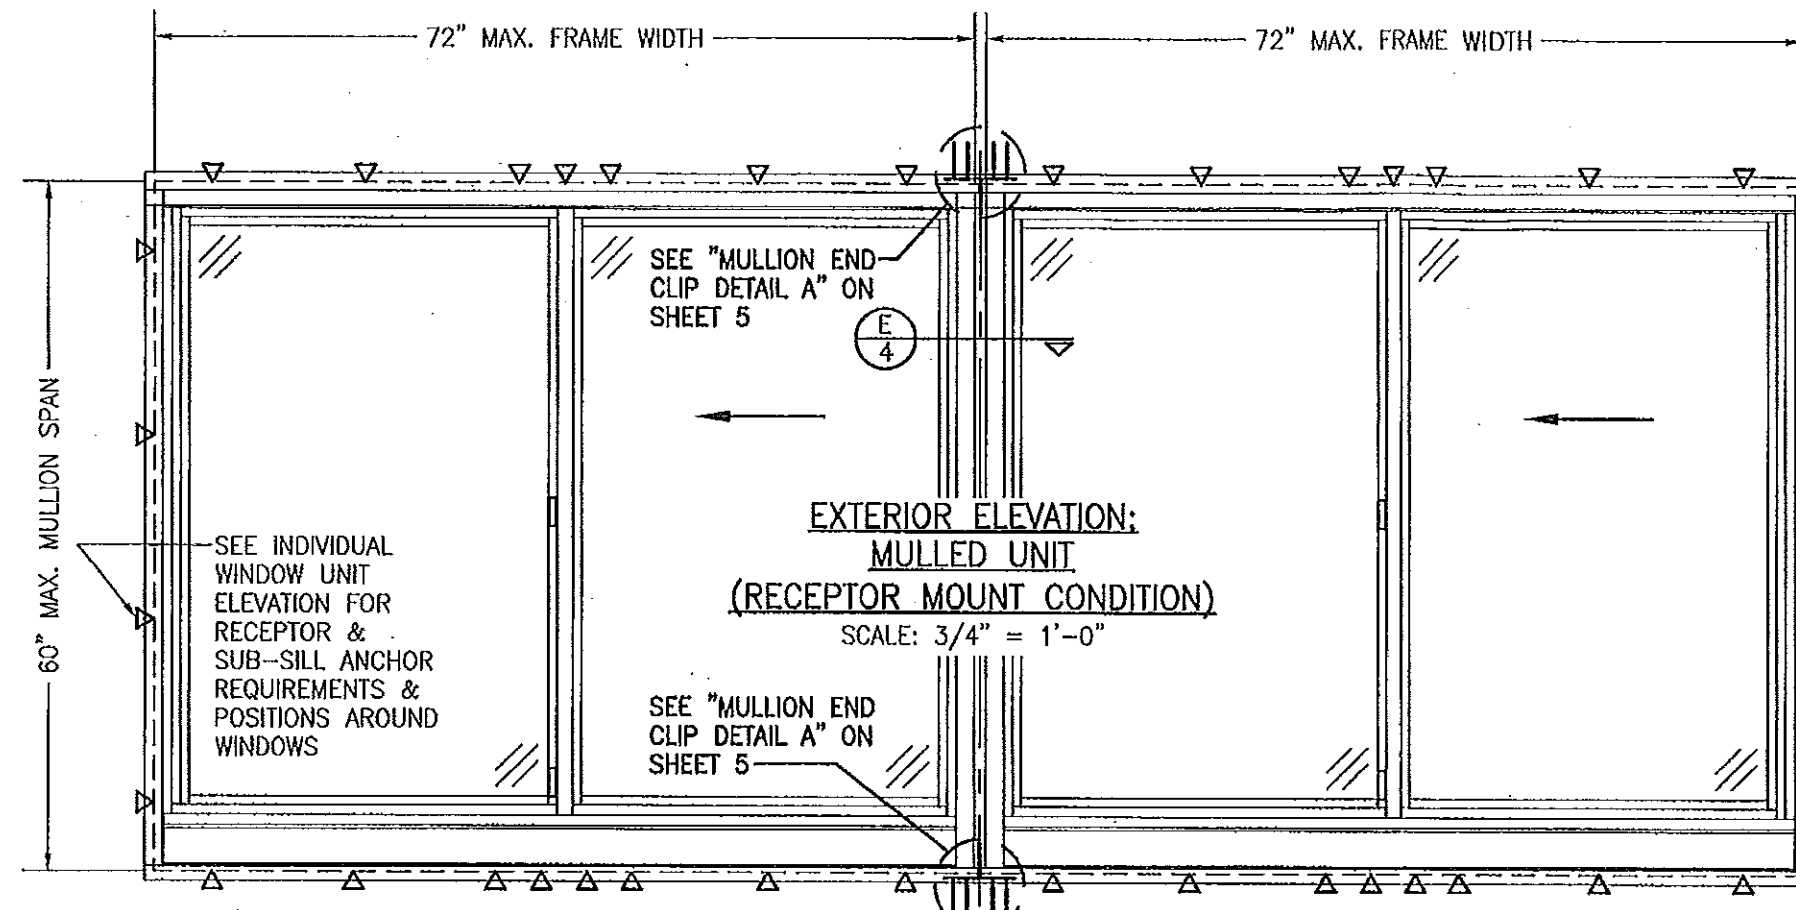

EXTERIOR ELEVATION:
MULLED UNIT
(RECEPTOR MOUNT CONDITION)
SCALE: 3/4" = 1'-0"

SEE "MULLION END
CLIP DETAIL A" ON
SHEET 5

SEE INDIVIDUAL
WINDOW UNIT
ELEVATION FOR
RECEPTOR &
SUB-SILL ANCHOR
REQUIREMENTS &
POSITIONS AROUND
WINDOWS

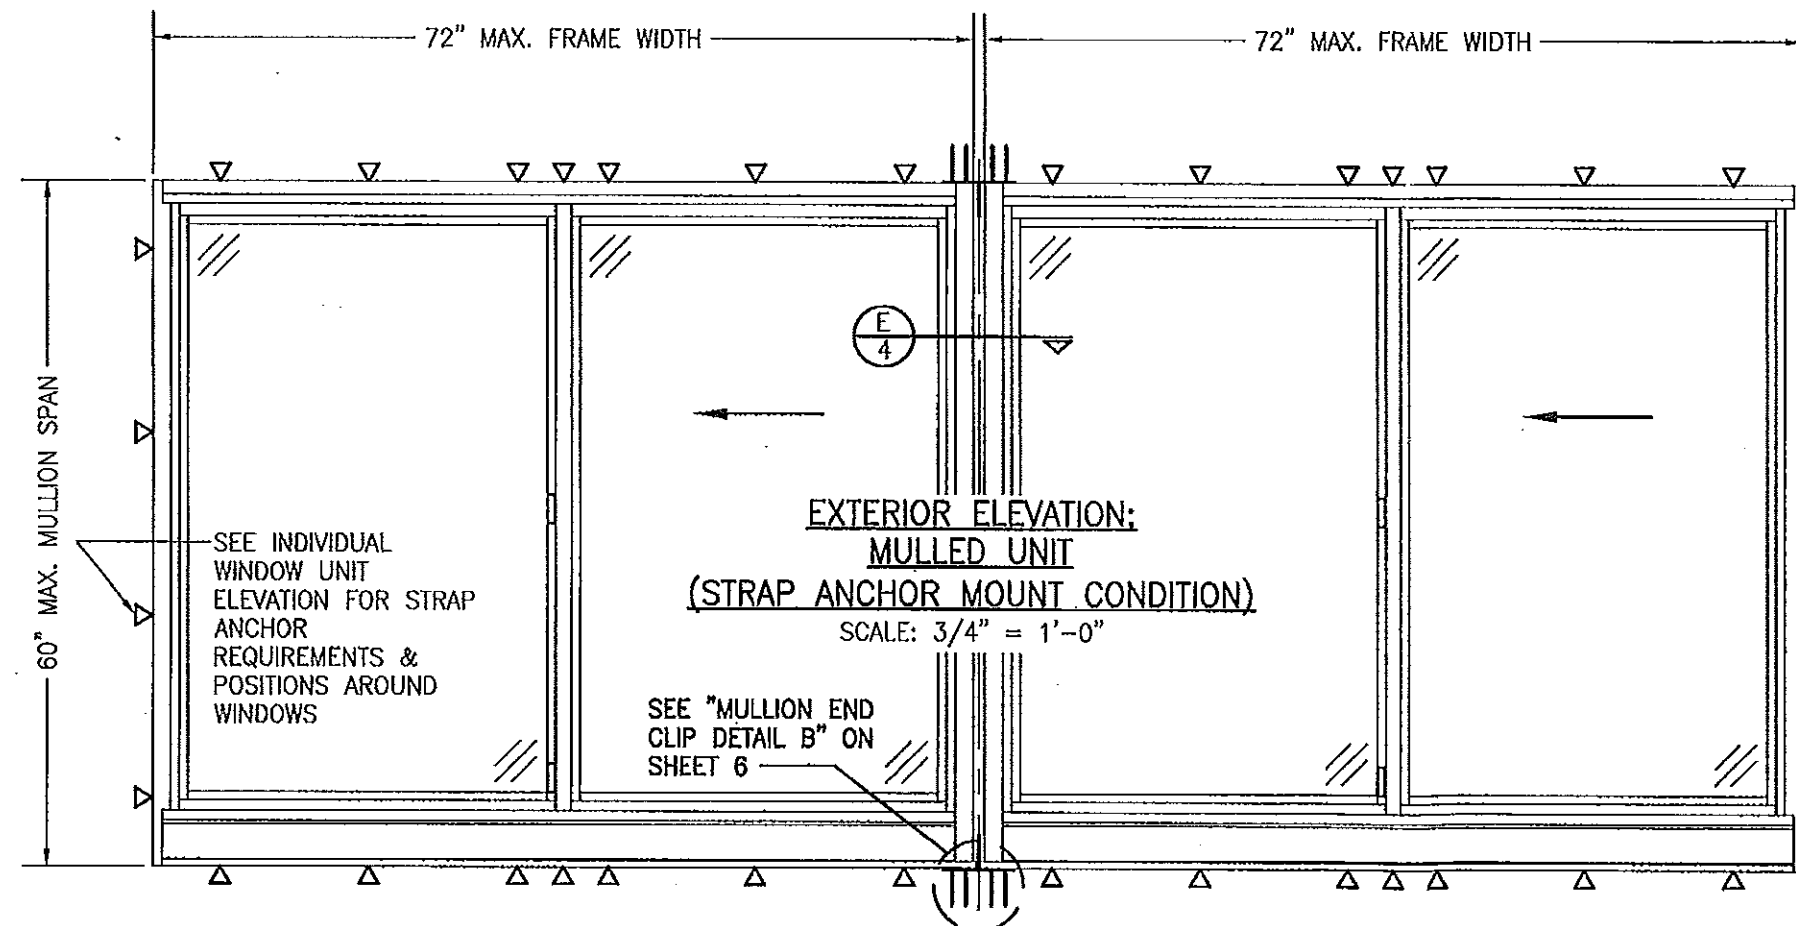

EXTERIOR ELEVATION:
MULLED UNIT
(STRAP ANCHOR MOUNT CONDITION)
SCALE: 3/4" = 1'-0"

SEE "MULLION END
CLIP DETAIL B" ON
SHEET 6

SEE INDIVIDUAL
WINDOW UNIT
ELEVATION FOR STRAP
ANCHOR
REQUIREMENTS &
POSITIONS AROUND
WINDOWS

MULLED UNIT NOTES:


1. FOR ALL DETAIL NOT SHOWN, SEE INDIVIDUAL WINDOW ELEVATIONS.
2. THERE IS NO LIMIT ON THE NUMBER OF WINDOWS THAT MAY BE COMBINED IN ONE DIRECTION INTO ONE OPENING PROVIDING THE OPENING IS DESIGNED TO SUPPORT ALL LOADS TRANSFERRED FROM THE WINDOWS & THEIR MULLIONS.
3. SUB-SILL & HEAD RECEPTOR RUN CONTINUOUS ACROSS MULLION JOINTS.


PRODUCT REVISED
as complying with the Florida
Building Code
Acceptance No. 14-0430.06
Expiration Date 10/06/2016
By *[Signature]*
Miami Dade Product Control

Approved as complying with the
Florida Building Code
Date 10/06/2011
NOAH 11-0705.12
Miami Dade Product Control
By *[Signature]*




DRAWN BY: W.R.M.		CHECKED BY: W.W.S.	
PLOT: 1=16		DATE: 08/13/11	
NO.	REVISION DESCRIPTION	DATE	BY
DRAWING TITLE 8400TL SLIDING GLASS WINDOW (SMALL MISSILE IMPACT)			
CONSULTANTS W. W. SCHAEFER ENGINEERING & CONSULTING, P.A. (CA 6809) 7480 150TH COURT NORTH PALM BEACH GARDENS, FL 33418 PHONE: 561-744-3424		MANUFACTURER KAWNEER COMPANY, INC. 555 GUTHRIE COURT NORCROSS, GA 30092 770-449-5555	
CERTIFICATION <i>[Signature]</i> SEP 21 2011 WARREN W. SCHAEFER, P.E. P.E. NO. 44135		DRAWING NO. 1757	
SHEET NO. 2 OF 7		REV.	

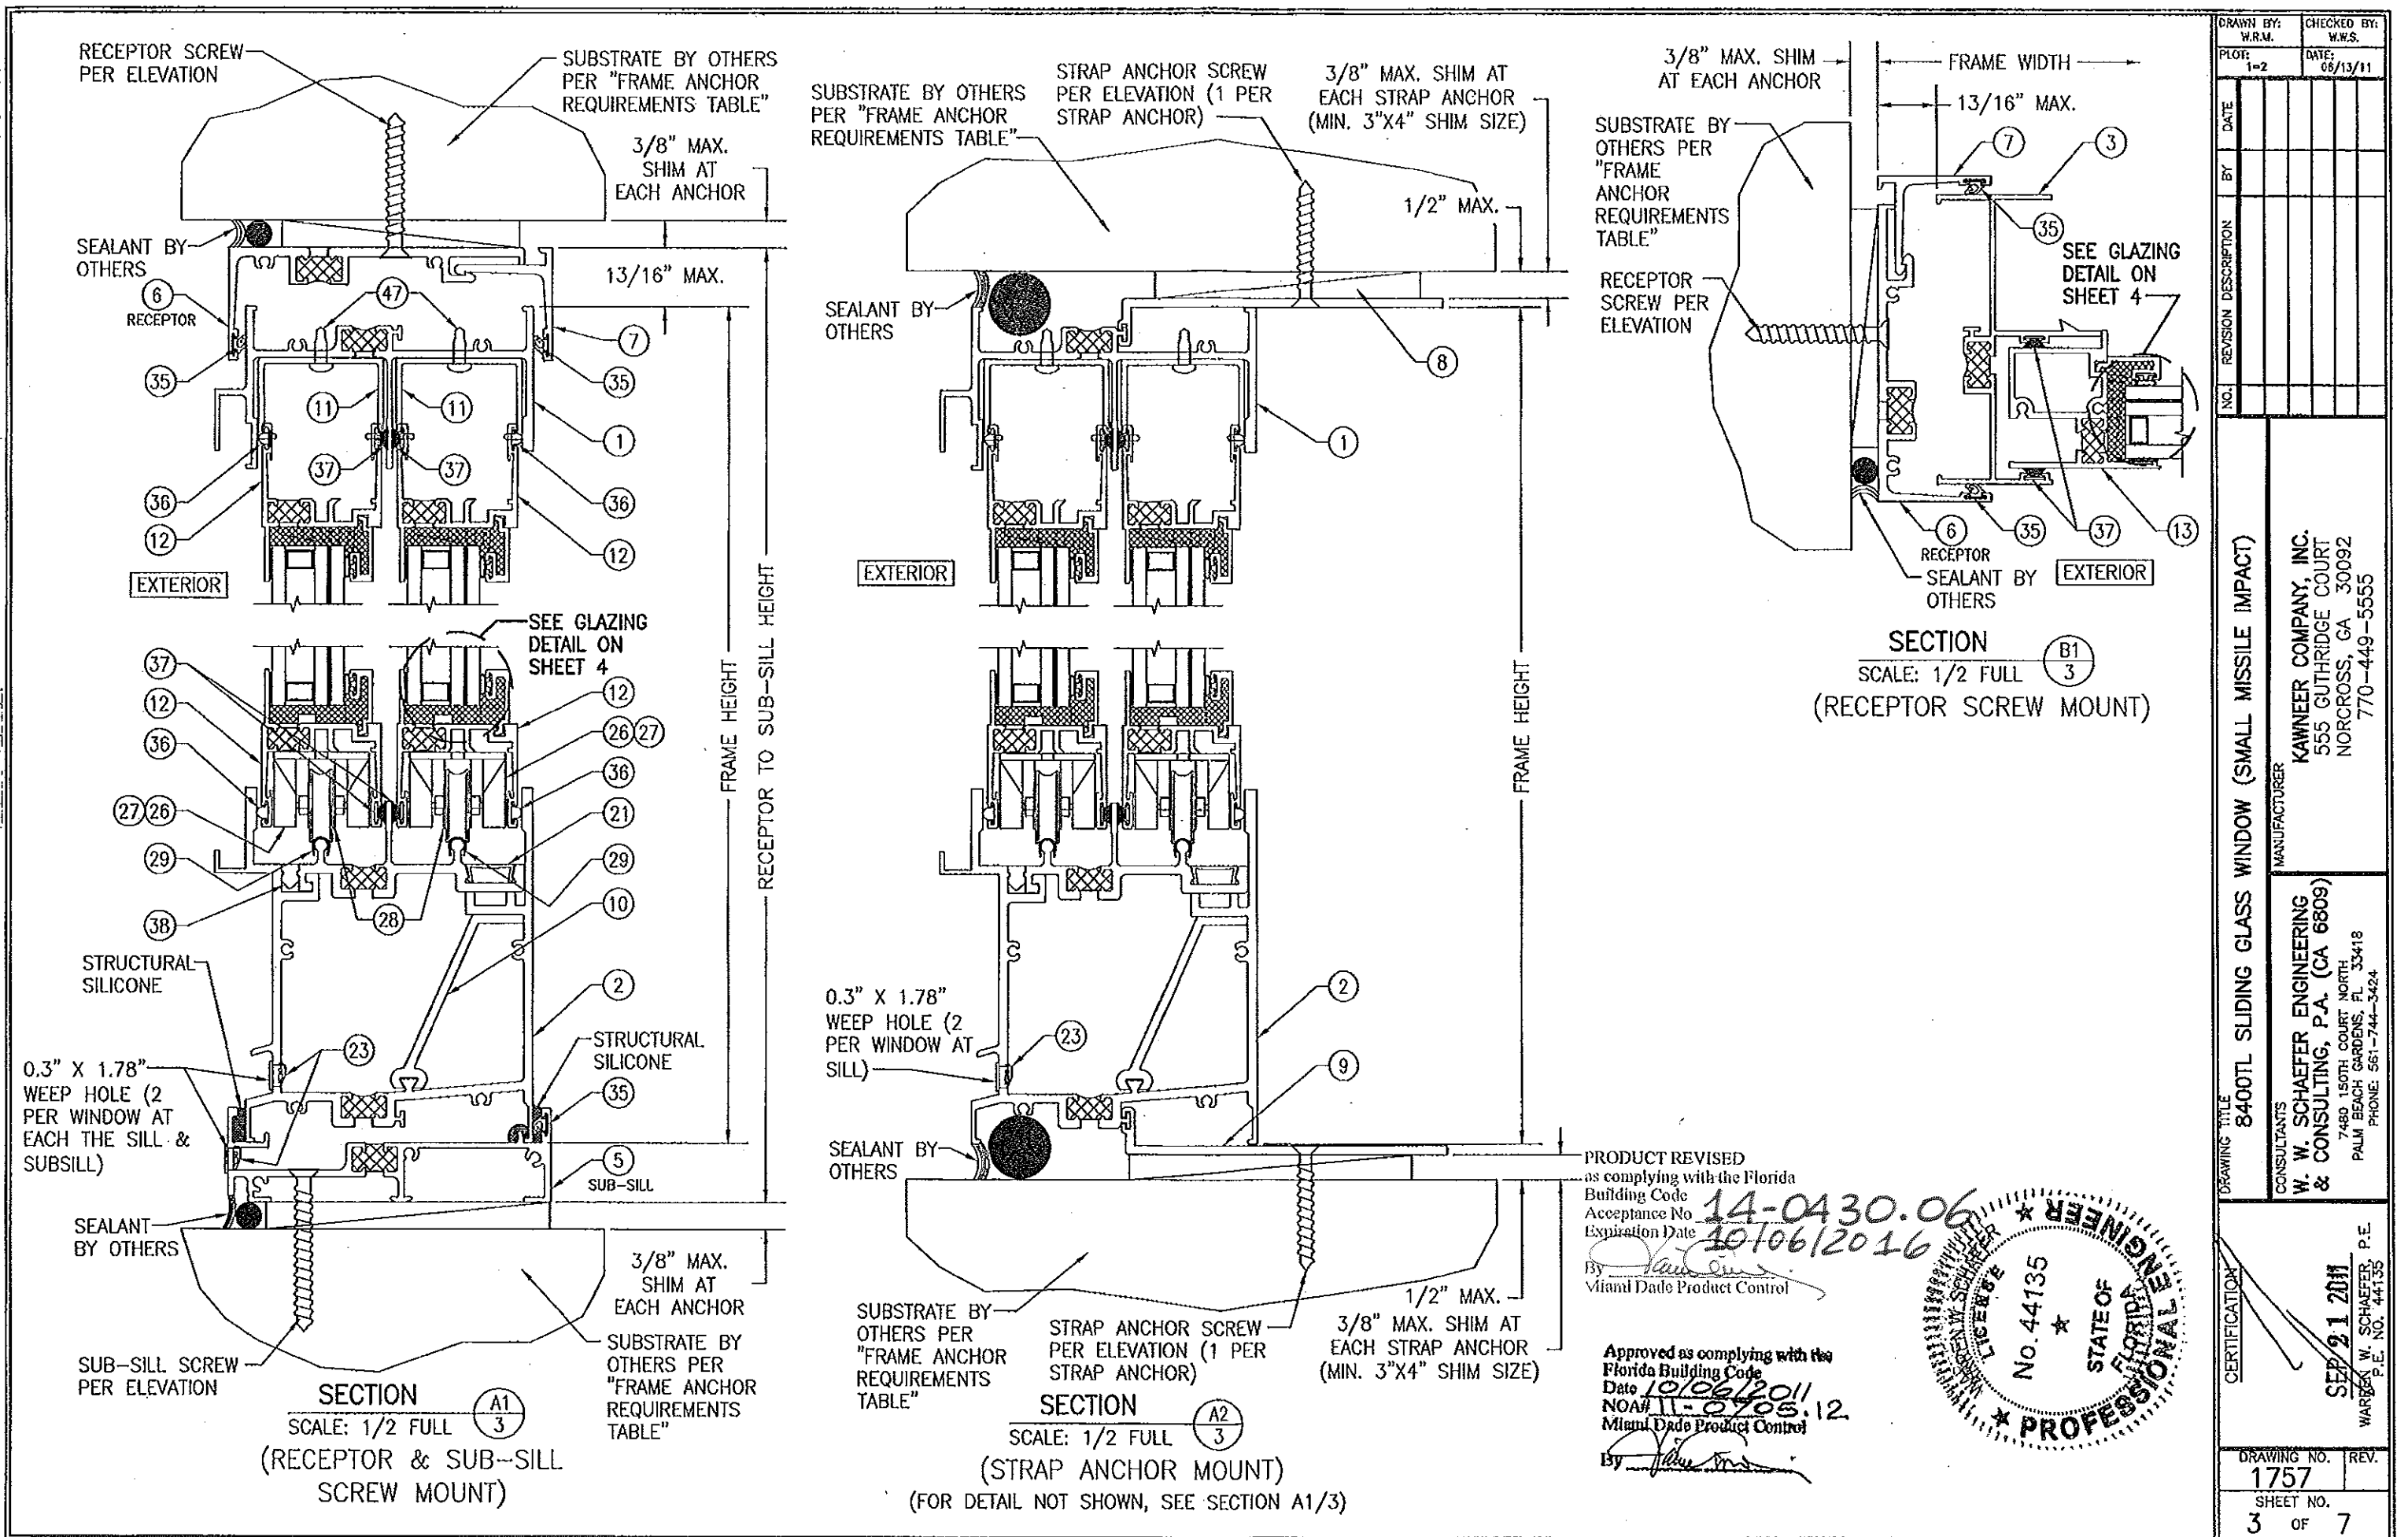


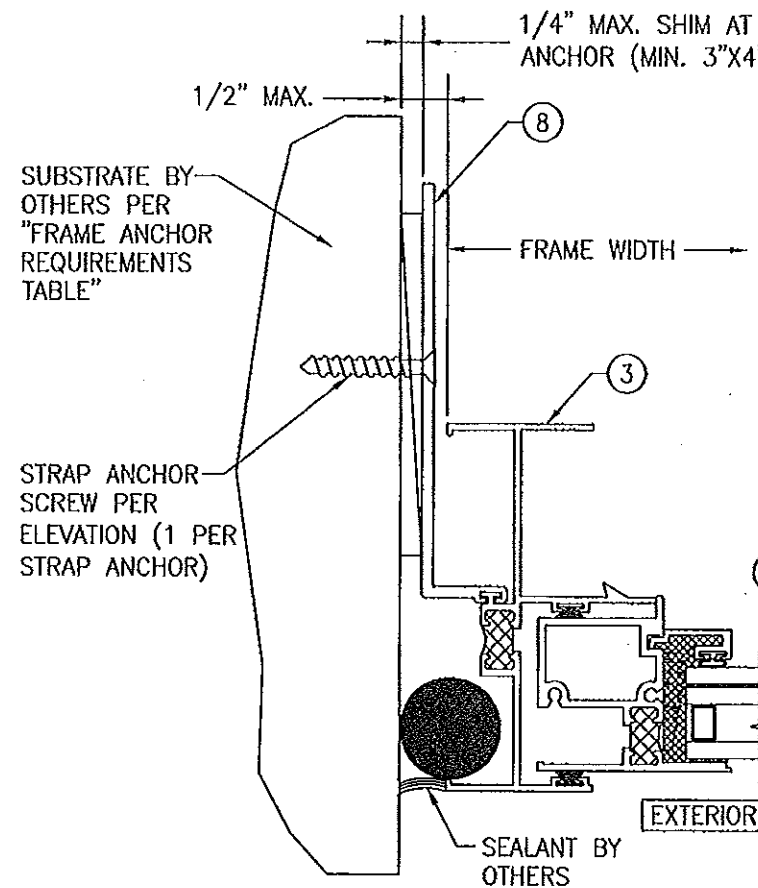

SECTION B2
SCALE: 1/2 FULL
(STRAP ANCHOR MOUNT)
(FOR DETAIL NOT SHOWN, SEE SECTION B1/3)

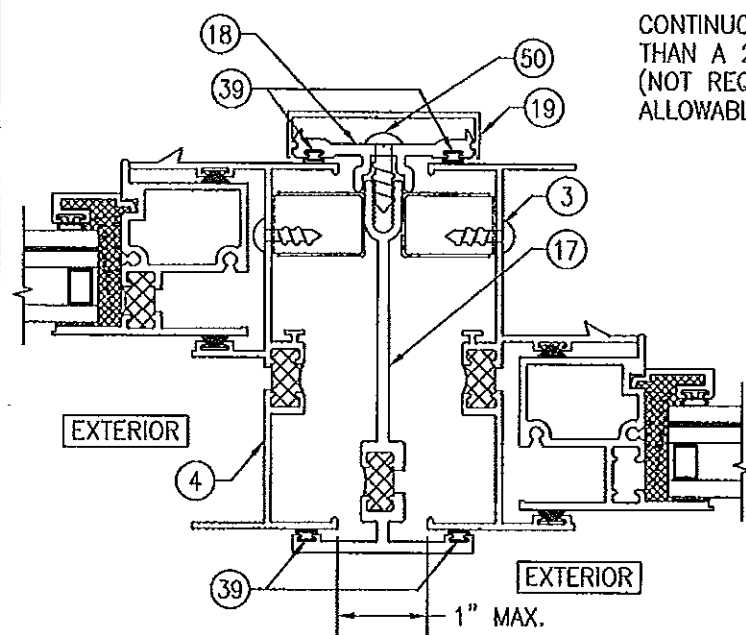


SECTION E
SCALE: 1/2 FULL
(FOR DETAIL NOT SHOWN, SEE OTHER SECTIONS)

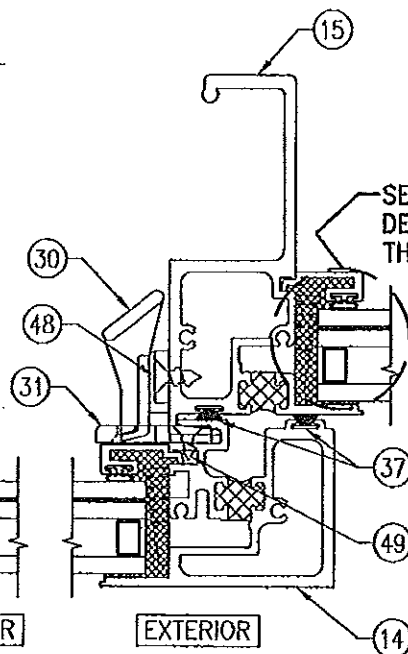


SECTION C
SCALE: 1/2 FULL

CONTINUOUS WOOD MEMBER LESS IN THICKNESS THAN A 2X4 BUCK TO BE MIN. 3 1/2" DEEP (NOT REQUIRED WHEN SHIM SPACE IS WITHIN ALLOWABLE DIMENSIONS SHOWN IN SECTIONS).

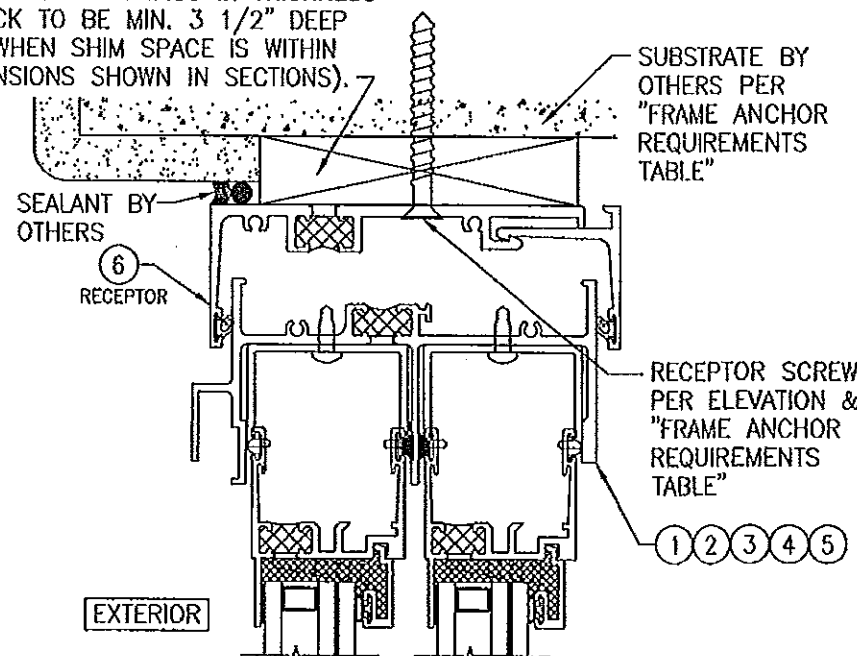


OPTIONAL DIRECT MOUNT DETAIL TO SUBSTRATE WITH SPACER


(HEAD SECTION SHOWN; SILL & SIDES ARE INSTALLED THE SAME)
(FOR DETAIL NOT SHOWN, SEE OTHER SECTIONS)

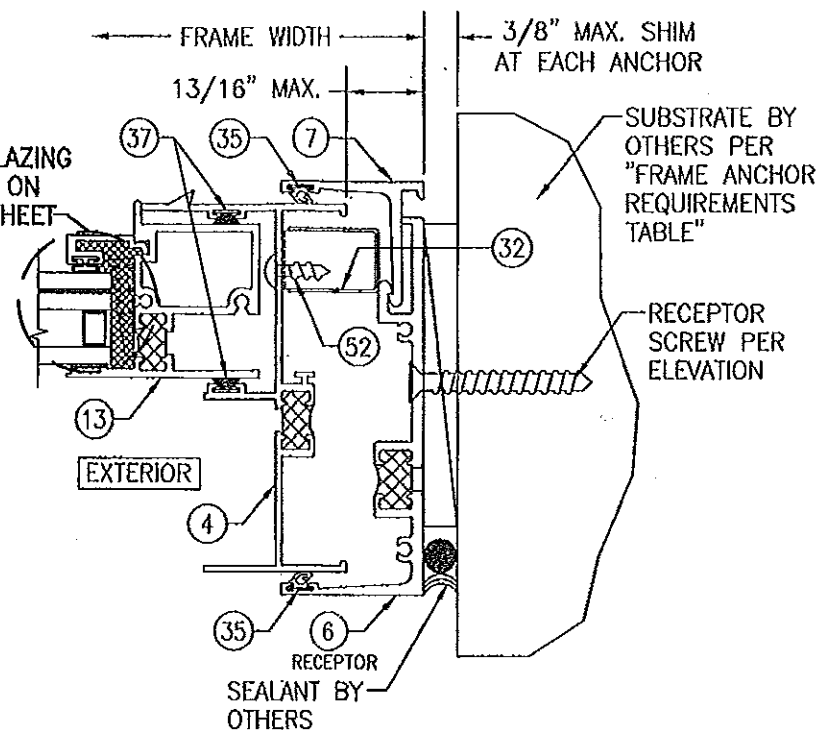

SECTION D1/4
SCALE: 1/2 FULL
(RECEPTOR SCREW MOUNT)

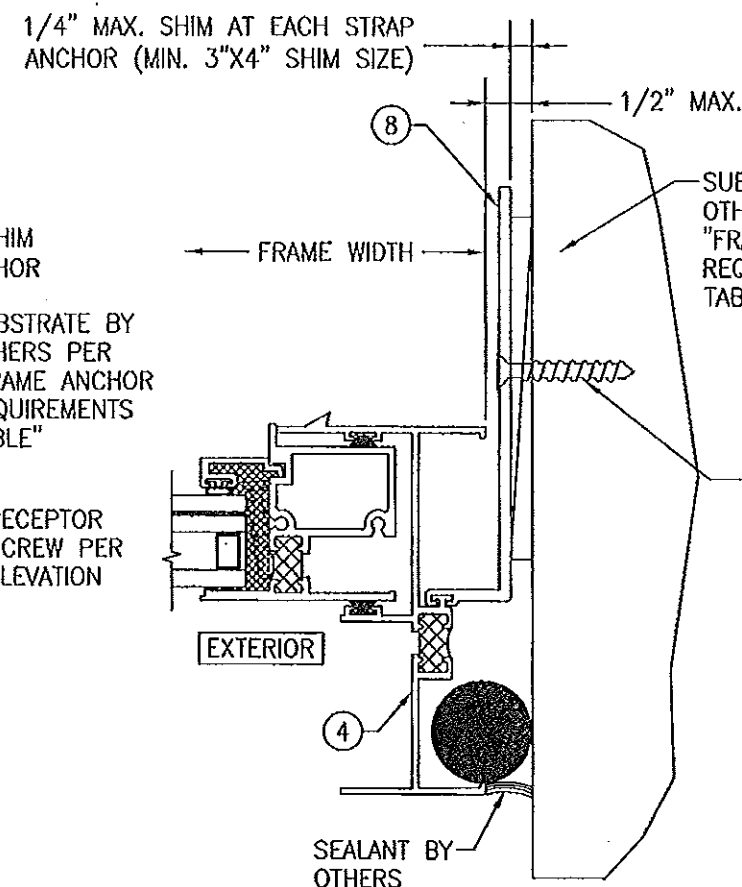

SECTION D2
SCALE: 1/2 FULL
(STRAP ANCHOR MOUNT)
(FOR DETAIL NOT SHOWN, SEE SECTION D1/4)

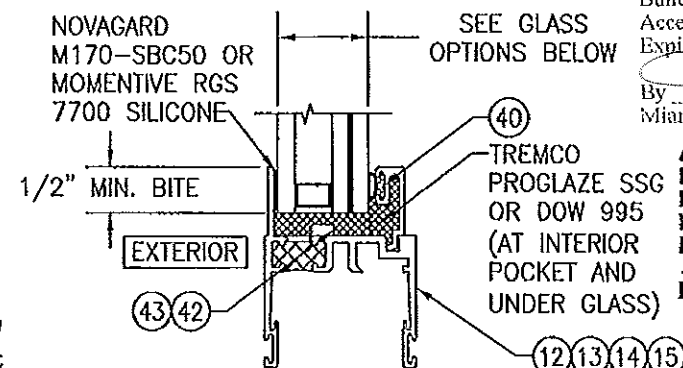

TYPICAL GLAZING DETAIL


GLASS OPTIONS:
OPTION 1: 1" THICK I.G. GLASS (3/16 TEMP. EXTERIOR; 3/8" SPACER; 3/16" HT. ST./0.06 SOLUTIA SAFLEX PVB/3/16" HT. ST. INTERIOR)
OPTION 2: 1" THICK I.G. GLASS (3/16 TEMP. EXTERIOR; 3/8" SPACER; 3/16" HT. ST./0.06 DUPONT BUTICITE PVB/3/16" HT. ST. INTERIOR)

PRODUCT REVISED as complying with the Florida Building Code
Acceptance No. 14-0430-0
Expiration Date 10/06/2016
By [Signature]
Miami Dade Product Control

Approved as complying with the Florida Building Code
Date 10/06/2016
NOA# 11-0705.12
Miami Dade Product Control
By [Signature]




DRAWN BY: W.R.L.	CHECKED BY: W.R.S.
PLT: 1-2	DATE: 06/13/11
DATE	BY
REVISION DESCRIPTION	NO.
DRAWING TITLE 8400TL SLIDING GLASS WINDOW (SMALL MISSILE IMPACT)	
MANUFACTURER KAWNEER COMPANY, INC. 555 GUTHRIE COURT NORCROSS, GA 30092 770-449-5555	
CONSULTANTS W. W. SCHAEFER ENGINEERING & CONSULTING, P.A. (CA 6809) 7480 150TH COURT NORTH PALM BEACH GARDENS, FL 33418 PHONE: 561-744-3424	
CERTIFICATION SEP 21 2011 WARREN W. SCHAEFER, P.E. P.E. NO. 44135	
DRAWING NO. 1757	REV.
SHEET NO. 4	OF 7

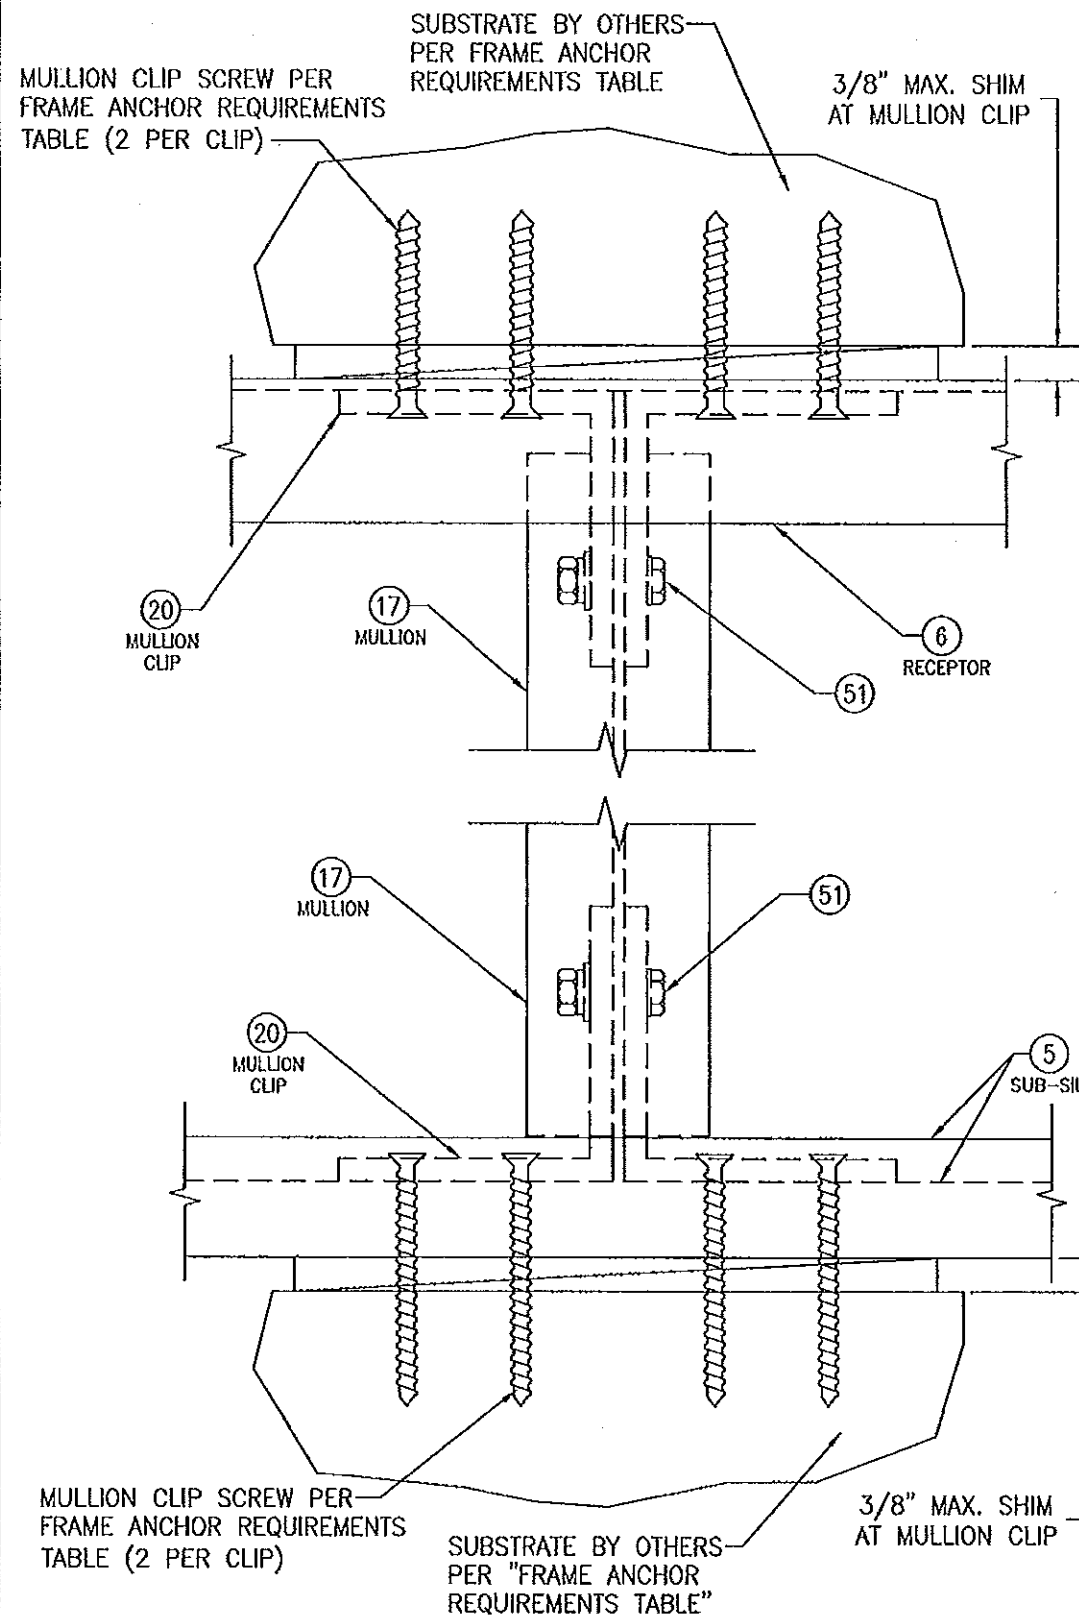

MULLION END CLIP DETAIL A

(FOR DETAIL NOT SHOWN, SEE OTHER SECTIONS)
(WINDOW COMPONENTS NOT SHOWN FOR CLARITY)

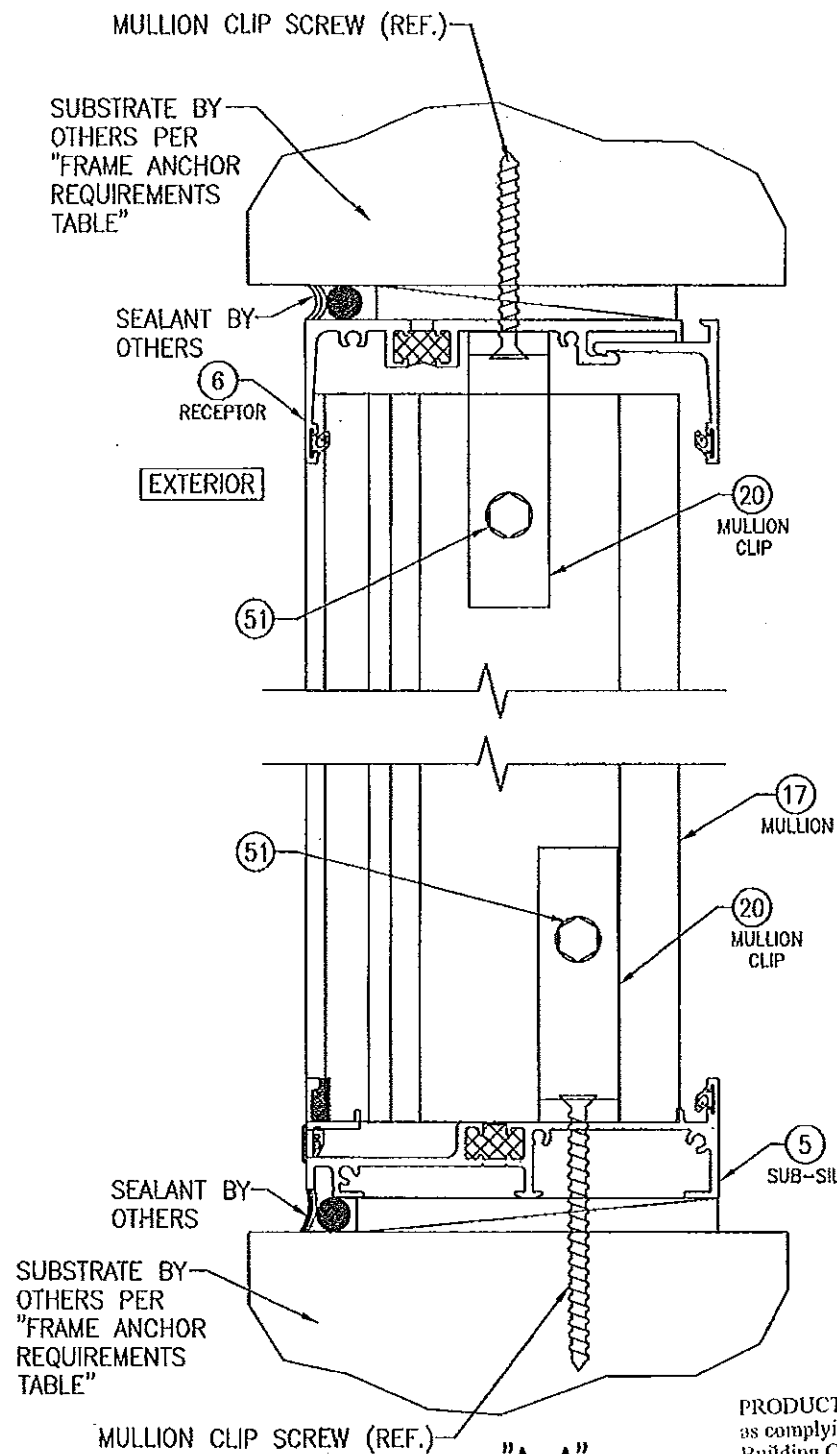

PRODUCT REVISED
as complying with the Florida
Building Code
Acceptance No. 14-0430.06
Expiration Date 10/04/2016
By *[Signature]*
Miami Dade Product Control



Approved as complying with the
Florida Building Code
Date 10/06/2011
NOA# 11-0705.12
Miami Dade Product Control
By *[Signature]*




DRAWN BY:	W.R.U.	CHECKED BY:	W.W.S.
PLOT:	1-2	DATE:	08/13/11
NO.		DATE	
BY			
REVISION DESCRIPTION			

DRAWING TITLE	8400TL SLIDING GLASS WINDOW (SMALL MISSILE IMPACT)
CONSULTANTS	W. W. SCHAEFER ENGINEERING & CONSULTING, P.A. (CA 6809)
MANUFACTURER	KAWNEER COMPANY, INC. 555 GUTHRIE COURT NORCROSS, GA 30092 770-449-5555
	7480 150TH COURT NORTH PALM BEACH GARDENS, FL 33418 PHONE 561-744-3424


CERTIFICATION	SEP 21 2011 W. W. SCHAEFER, P.E. P.E. NO. 44135
DRAWING NO.	1757
SHEET NO.	5 OF 7

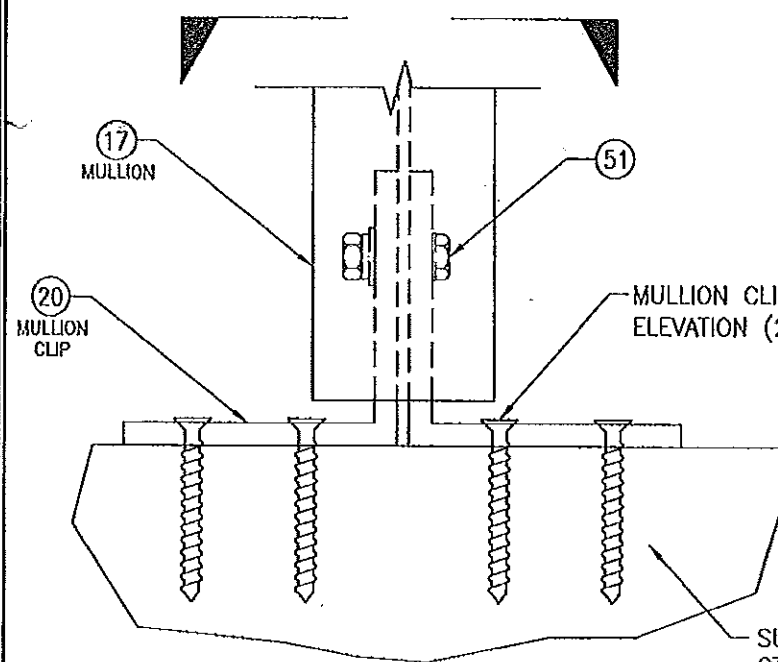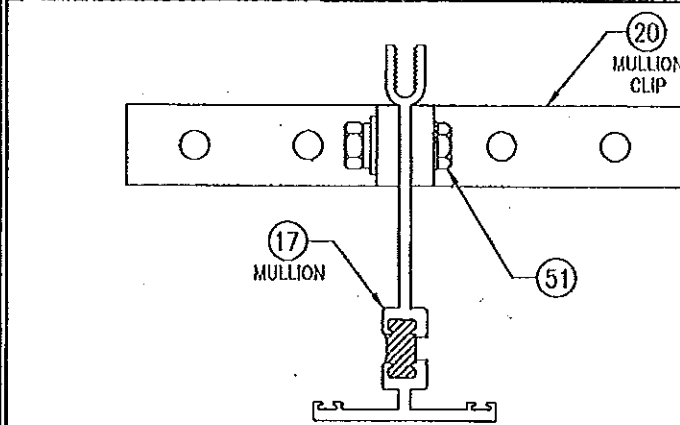


MULLION END CLIP DETAIL B
(SILL SECTION SHOWN, HEAD IS THE SAME)
(WINDOW COMPONENTS NOT SHOWN FOR CLARITY)

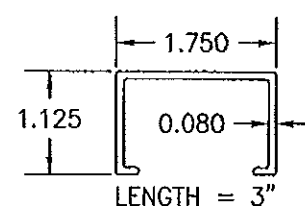


11 SASH STOP

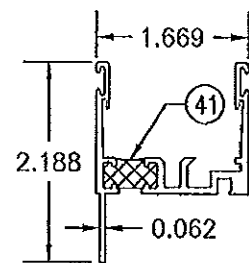


12 RAIL

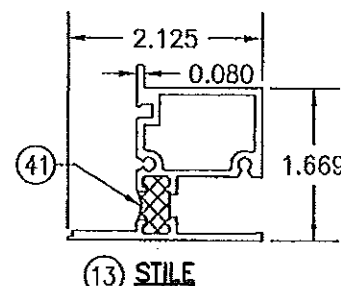


13 STILE

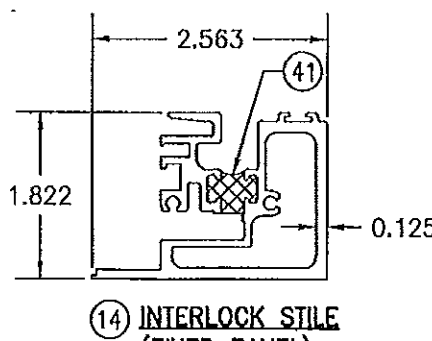


14 INTERLOCK STILE (FIXED PANEL)

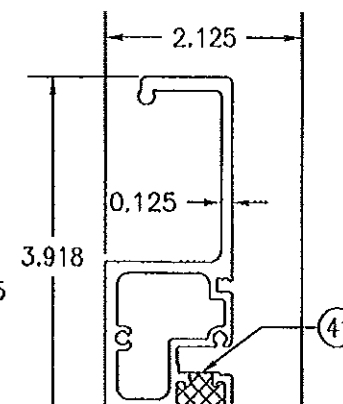


15 INTERLOCK STILE (OPERABLE PANEL)

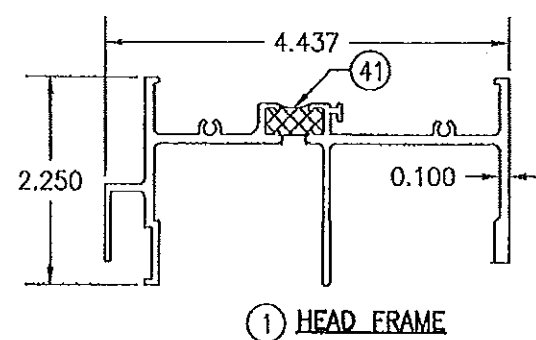


1 HEAD FRAME

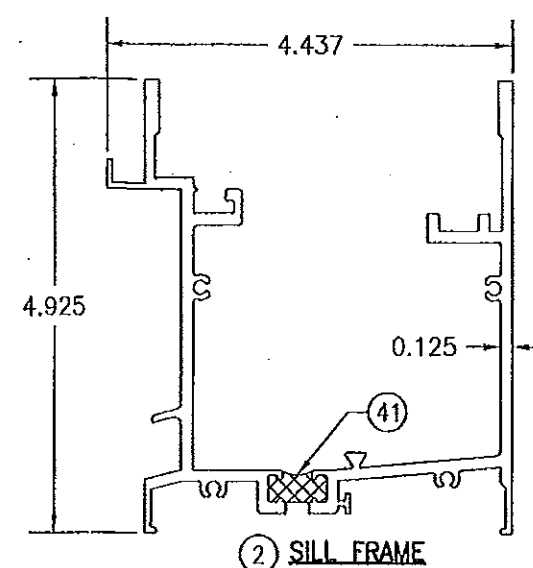


2 SILL FRAME

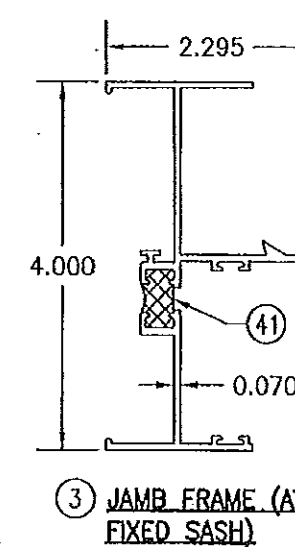


3 JAMB FRAME (AT FIXED SASH)

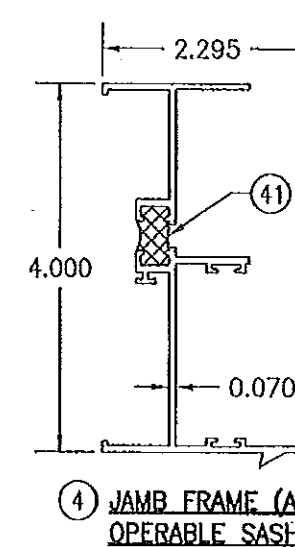


4 JAMB FRAME (AT OPERABLE SASH)

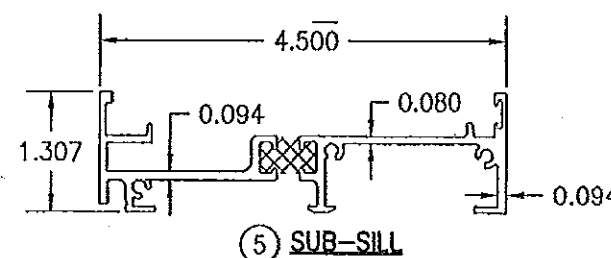


5 SUB-SILL

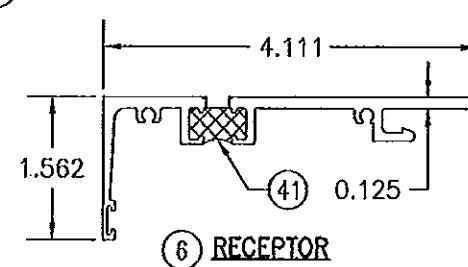


6 RECEPTOR

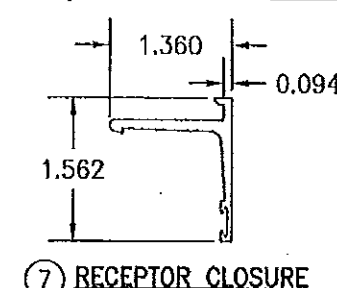


7 RECEPTOR CLOSURE

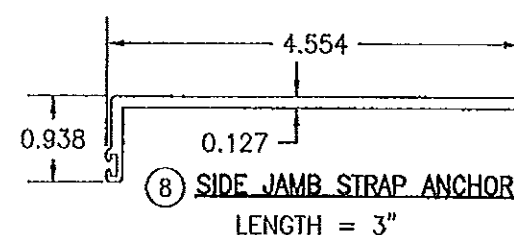

8 SIDE JAMB STRAP ANCHOR
LENGTH = 3"

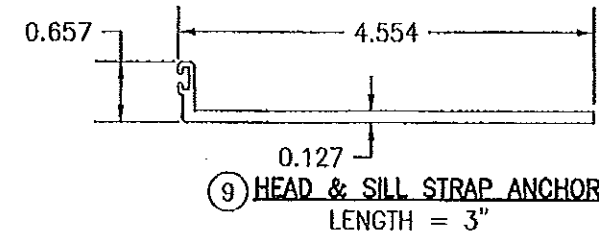

9 HEAD & SILL STRAP ANCHOR
LENGTH = 3"

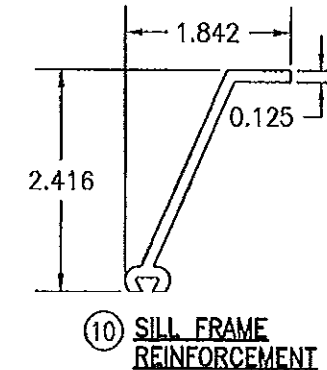

10 SILL FRAME REINFORCEMENT

PRODUCT REVISED
as complying with the Florida
Building Code
Acceptance No. 14-0430.06
Expiration Date 10/06/2016
By *[Signature]*
Miami Dade Product Control

Approved as complying with the
Florida Building Code
Date 10/06/2011
NOA# 11-8-20512
Miami Dade Product Control
By *[Signature]*



DRAWN BY: W.R.M.	CHECKED BY: W.W.S.
PLOT: 1-2	DATE: 08/13/11
DATE	BY
REVISION DESCRIPTION	NO.
DRAWING TITLE 8400TL SLIDING GLASS WINDOW (SMALL MISSILE IMPACT)	
MANUFACTURER KAWNEER COMPANY, INC. 555 GUTHRIE COURT NORCROSS, GA 30092 770-449-5555	
CONSULTANTS W. W. SCHAEFER ENGINEERING & CONSULTING, P.A. (CA 6809) 7480 150TH COURT NORTH PALM BEACH GARDENS, FL 33418 PHONE: 561-744-3424	
CERTIFICATION	SEP 21 2011 WARREN W. SCHAEFER, P.E. P.E. NO. 44135
DRAWING NO. 1757	REV.
SHEET NO. 6	OF 7

